



(2) 3D PERSPECTVE

GENERAL NOTES:

- ALL WORK TO BEST INDUSTRY STANDARDS AND TO CURRENT CANADIAN NATIONAL BUILDING CODE. ALL FABRICATION AND ERECTION SHALL BE IN ACCORDANCE WITH THIS CODE. SUB-STANDARD WORK WILL BE REFUSED BY CLIENT AND PROFESSIONAL SERVICE TEAMS.
 THE CONTRACTOR IS RESPONSIBLE FOR THE DESIGN AND ERECTION OF ALL TEMPORARY SUPPORTS AND FRAMEWORK.
 THE CONTRACTOR IS RESPONSIBLE FOR ALL SITE SAFETY REQUIRED BY LOCAL LEGISLATION.
 ALL MEASUREMENT DISCREPANCIES, ANDIOR PROPOSED CONSTRUCTION OF HANGES DIFFERING SUBSTANTIALLY FROM THAT SHOWN ON THE DRAWINGS MUST BE REPORTED TO THE ARCHITECTURAL! ENGINEERING ANDIOR

- CLIENT PRIOR TO CONTINUING WORK. DO NOT SCALE THESE DRAWINGS.

- 9. 10. 11. 12. 13. 14. 15.

- DO NOT SCALE THESE BRAWNINGS.

 VERIFY SITE AND SOLL CONDITIONS BEFORE BEGINNING CONSTRUCTION. AS REOD BY CLIENT AND JURISDICTION.
 ALL DIMENSIONS ARE FROM FACE OF STUD TO FACE OF STUD UNLESS UNLESS FROM EXTERIOR SHEATHED WALL OR NOTED AS BEING A CLEAR DIMENSION. CLEAR DIMENSIONS ARE FROM FINISH SURFACE TO FINISH SURFACE.
 CONFIRM ALL ROUGH OPENING REQUIREMENTS FOR PLUMBING FIXTURES WITH SUPPLIERS PRIOR TO FRAMING.
 CONFIRM ALL ROUGH OPENING REQUIREMENTS FOR WINDOWS AND DOORS WITH SUPPLIERS PRIOR TO FRAMING.
 CONFIRM ALL ROUGH OPENING REQUIREMENTS FOR WINDOWS AND DOORS WITH SUPPLIERS PRIOR TO FRAMING.
 CONFIRM ALL FLOOR AND ROOF JOIST SIZE, LOCATIONS AND SPACING WITH APPROVED SUPPLIER SENSE TO BE TAPED, MUD AND SANDED.
 CONFIRM ALL HLOOR AND ROOF JOIST SIZE, LOCATIONS AND SPACING WITH APPROVED SUPPLIER SIGNISEERING LAYOUTS.
 CONFIRM ALL MANUFACTURED COMPONENTS. THROUGH USE OF PRE-APPROVED SHOP DRAWNINGS IS RESPONDENT OF CONTRACTOR.
 CONFIRM TRANSPORT FRAME, FLOOR AND ROOF JOIST SIZE, LOCATIONS AND SPACING WITH APPROVED SUPPLIER SENSE THE REGINEERING LAYOUTS.
 ALL SPECIFIED STELL STRUCTURAL SUPPORTS TO BE APPROVED BY BY DRAWNINGS IN SERSE OF THE APPROVED SHOP BACK FILL HEIGHTS WITH GRADING PLAN.
- ALL WOOD TO AVOID DIRECT CONTRICT WITH CONCRETE AND/OR GRADE MATERIAL. PITW TO BE USED IN PROXIMITY TO GRADE. SHEAR WALLS TO COMPORM TO ENG. SPECIFICATION INCLUDING NAILING PATTERN, TIE DOWN BOLTS AND PLYWOOD SHEAR WALL IT WILL WALL SPECIFICATIONS. TRUSS! JOIST MANUFACTURER TO ALIGN SHEAR WALLS WITH STRUCTURAL BEAMS AND HOLD DOWN STRUCTURAL TIE DOWN EQUIVALENT. AIR BARRIER TO BE TESTED AND MAINTAINED ON SITE. PENETRATIONS TO BARRIER TO BE CONTROLLED BY CONTRACTOR AND SUBTRADES.
 ALL PASTENERS AND ADHESINES TO COMPLY WITH NBC 2010. 16.



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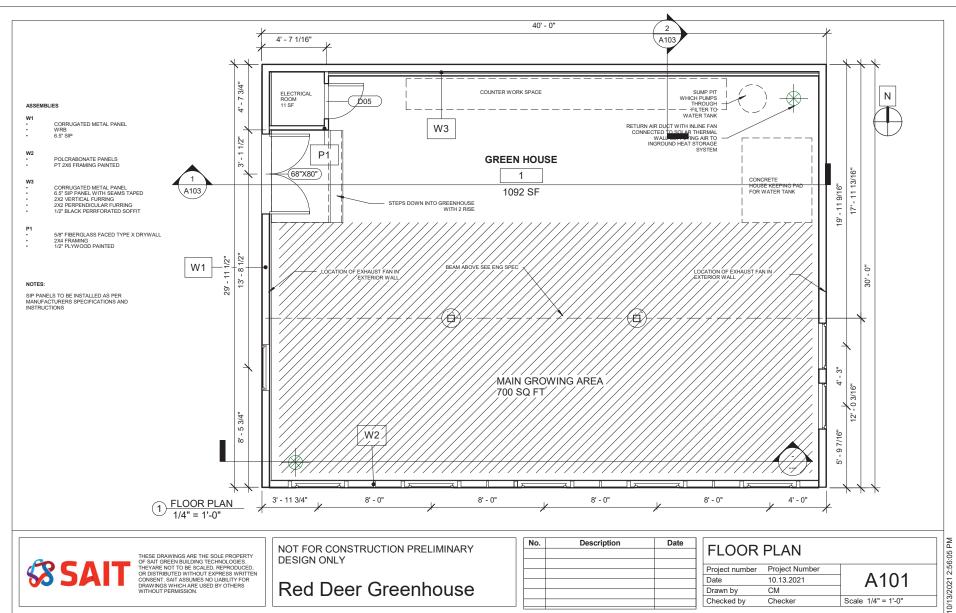
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Red Deer Greenhouse

	NO.	Description	Date

SITE PLAN			
Project number	Project Number		
Date	10.13.2021	A100	
Drawn by	CM	71100	
Checked by		Scale 1 : 200	

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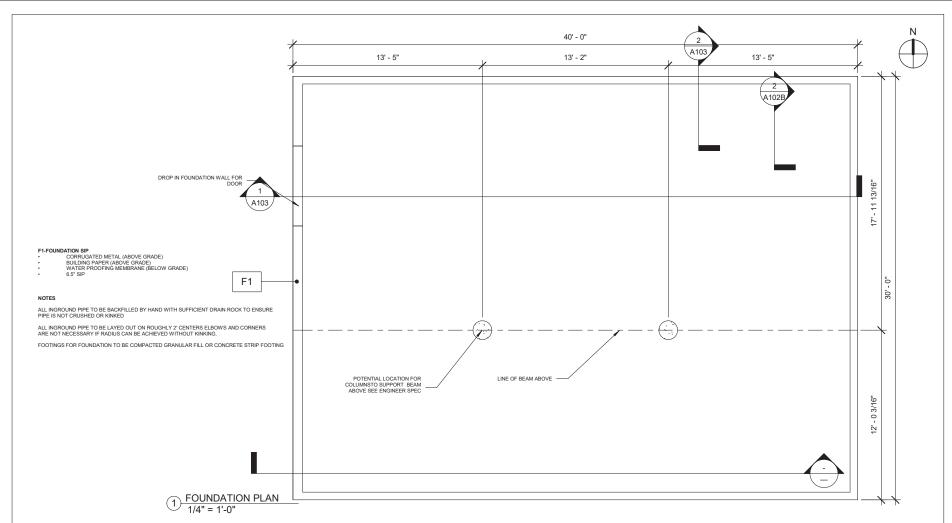


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Red Deer Greenhouse

No.	Description	Date

FLOOR PLAN			
Project number	Project Number		
Date	10.13.2021	A101	
Drawn by	CM	71101	
Checked by	Checker	Scale 1/4" = 1'-0"	





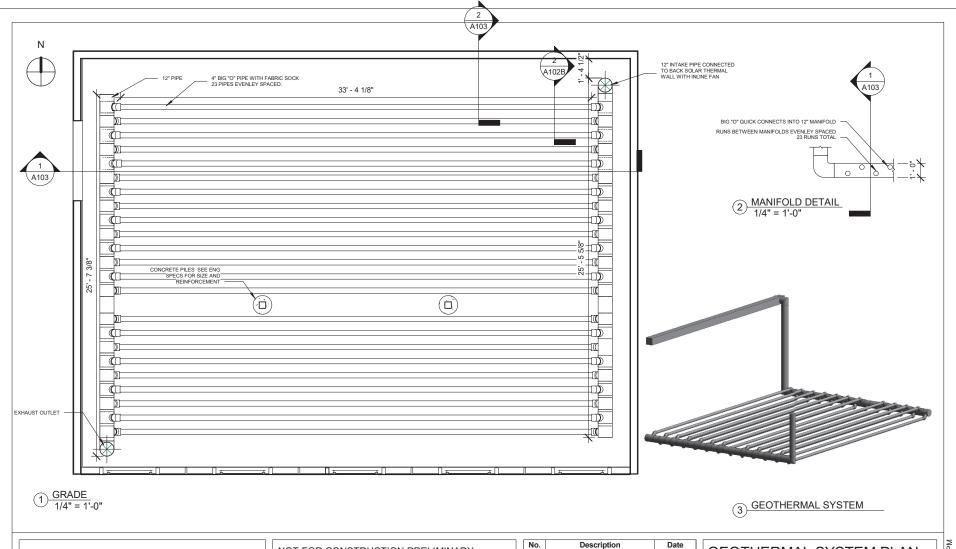
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Red Deer Greenhouse

No.	Description	Date

FOUNDATION PLAN			
Project number	Project Number		
Date	10.13.2021	A102	
Drawn by	CM	71102	
Checked by	Checker	Scale 1/4" = 1'-0"	

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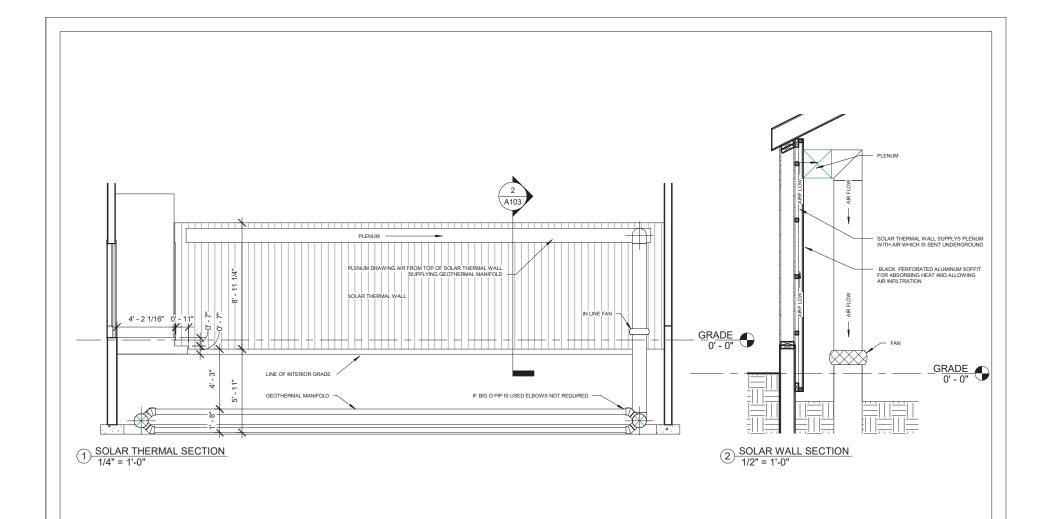
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Red Deer Greenhouse

Description	Date
	Description

Project number	Project Number	
Date	10.13.2021	A102B
Drawn by	CM	711020
Checked by	Checker	Scale 1/4" = 1'-0"

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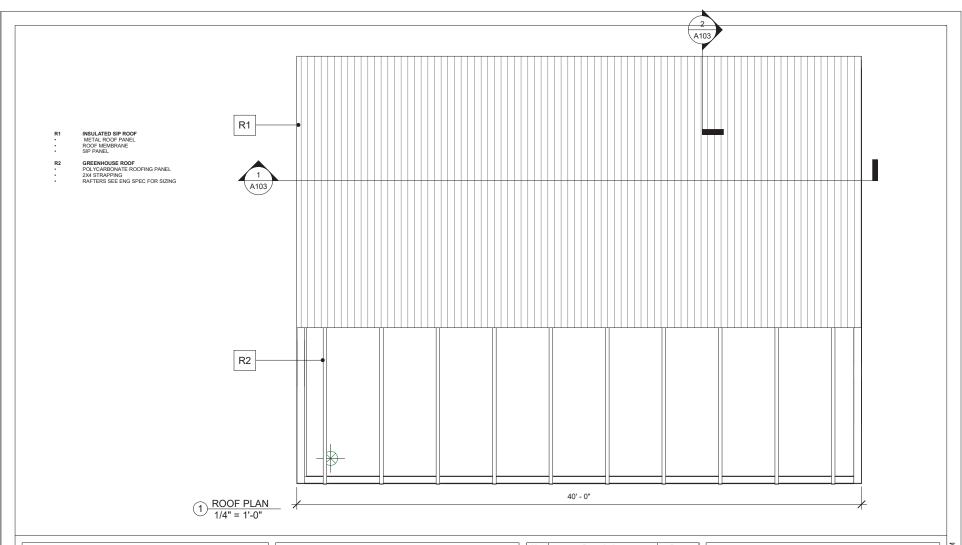
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Red Deer Greenhouse

No.	Description	Date

Project number	Project Number	
Date	10.13.2021	A103
Drawn by	Author	71100
Checked by	Checker	Scale As indicated

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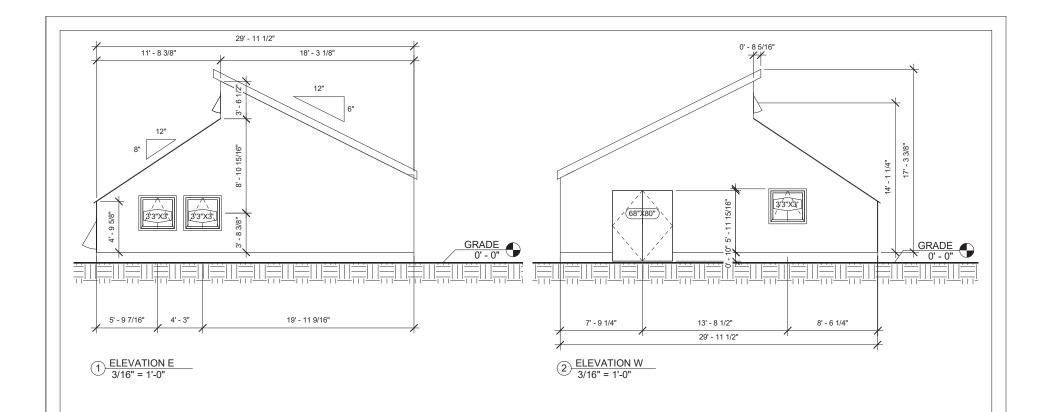
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Red Deer Greenhouse

No.	Description	Date

ROOF PLAN			
Project number	Project Number		
Date	10.13.2021	A104	
Drawn by	CM	7 7 1 1 3 1	
Checked by	Checker	Scale 1/4" = 1'-0"	

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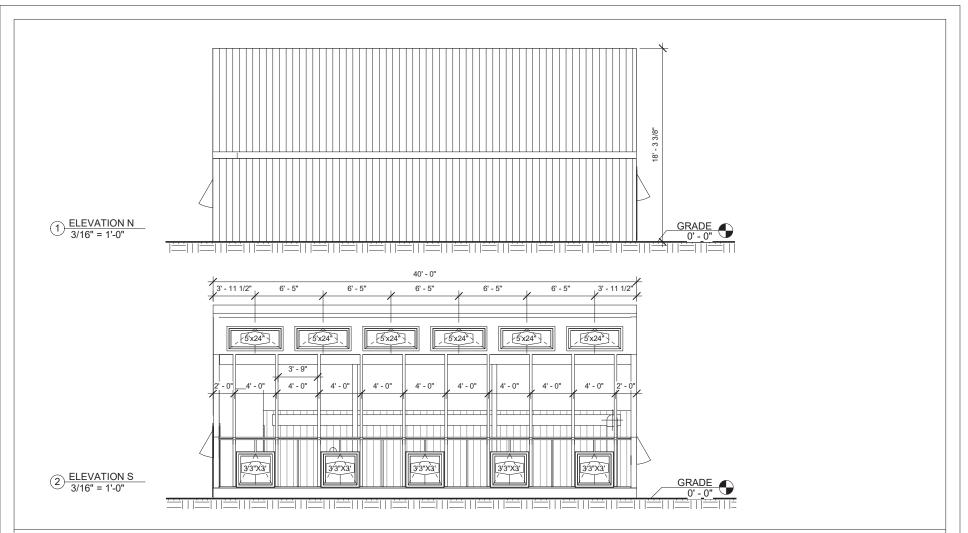
Red Deer Greenhouse

No.	Description	Date

FAST	WEST	FI F	VATION

Project number	Project Number	
Date	10.13.2021	A105
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Checked by	Checker	Scale 3/16" = 1'-0"

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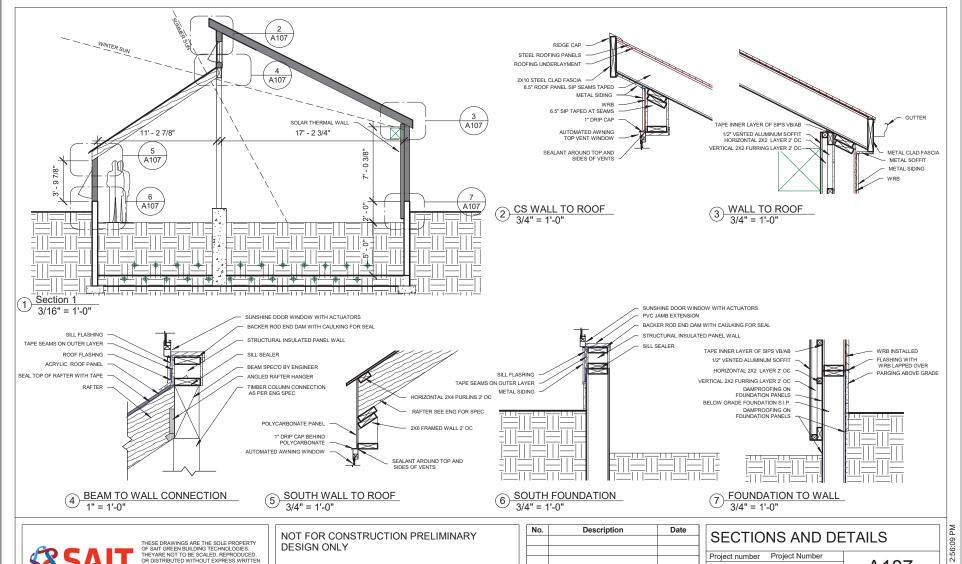
Red Deer Greenhouse

No.	Description	Date

NORTH &	SOUTH EL	_EVATION

Project number	Project Number	
Date	10.13.2021	A106
Drawn by	CM	71100
Checked by	Checker	Scale 3/16" = 1'-0"

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Red Deer Greenhouse

No.	Description	Date

Project number	Project Number	
Date	10.13.2021	A107
Drawn by	Author	, , , , ,
Checked by	Checker	Scale As indicated

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